


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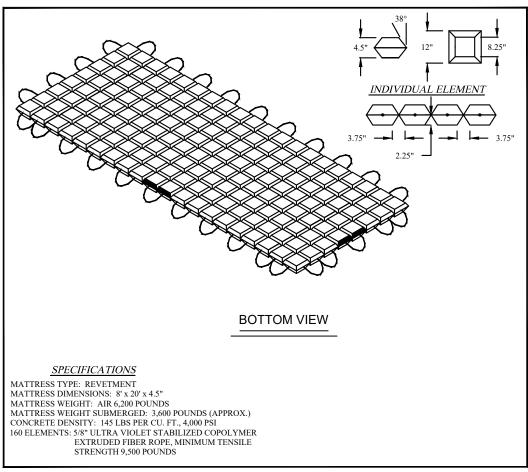
SWG-2018-00547; Page 2 of 5 REVISION HIGHBANK EDITED TITLEBLOCK INFO 2/12/2019 **EXISTING** REVISED TO 8.5x11 FORMAT. 4/3/2019 STA. 2+24 STRUCTURE STA. 2+16 ADDED MAT NOTE DEPTH OF COVER 4.25' DEPTH OF COVER 5.5' STA. 2+08 4+00 DEPTH OF COVER 10.5' 1+00 KINDER MORGAN 20" 128-000 PIPELINE EDGES OF THE MAT SYSTEM WILL STA. 1+95 SUBMAR MAT SYSTEM BE JETTED IN RESULTING IN THE **DEPTH OF COVER 9.5'** 8' x 20' (14 TOTAL) PLACEMENT OF APPROX. 34 CYS OF NATIVE FILL **EXISTING EXISTING** CAMP GROUND MARSH **PLAN VIEW BEGIN MAT PLACEMENT** N29.83345 3+77 END MAT PLACEMENT SCALE: 1" = 60' 4+61 DEPTH OF COVER 5.25' W94.80322 DEPTH OF COVER 3' ELEV. 29.7' CONTRACTING, INC., PROJECT NO.17177MD, DWG # P4 DATED 12/3/2017. END EXPOSURE LINE IS CONCRETE COATED. A 3' x 2' SECTION OF CONC. COATING IS REMOVED AT STA. 2+85 PER REFERENCED REPORT 20" PIPELINE IS EXPOSED FROM THE 9 O' CLOCK POSITION TO 3 O' CLOCK POSITION PER REFERENCED REPORT. (SEE SURVEY NOTE NO. 3). EXISTING GRADE MARSH / MUD SUBMAR MAT SYSTEM 20 8' x 20' (14 TOTAL) **∀** MHTL +0.90′ WATER LEVEL (12/2/1 KINDER MORGAN --20 -20 20" 128-000 PIPELINE 0+001+00 2+00 3+00 4+00 5+00 6+00 **PROFILE VIEW** 60' 120' 180' SCALE: 1" = 60' (HORIZ.) SCALE: 1"=60' SITE LOCATION: N29.83371° W94.80201° SCALE: 1" = 60' (VERT.) SHEET TITLE: LEGEND: LOST LAKE (OLD RIVER)

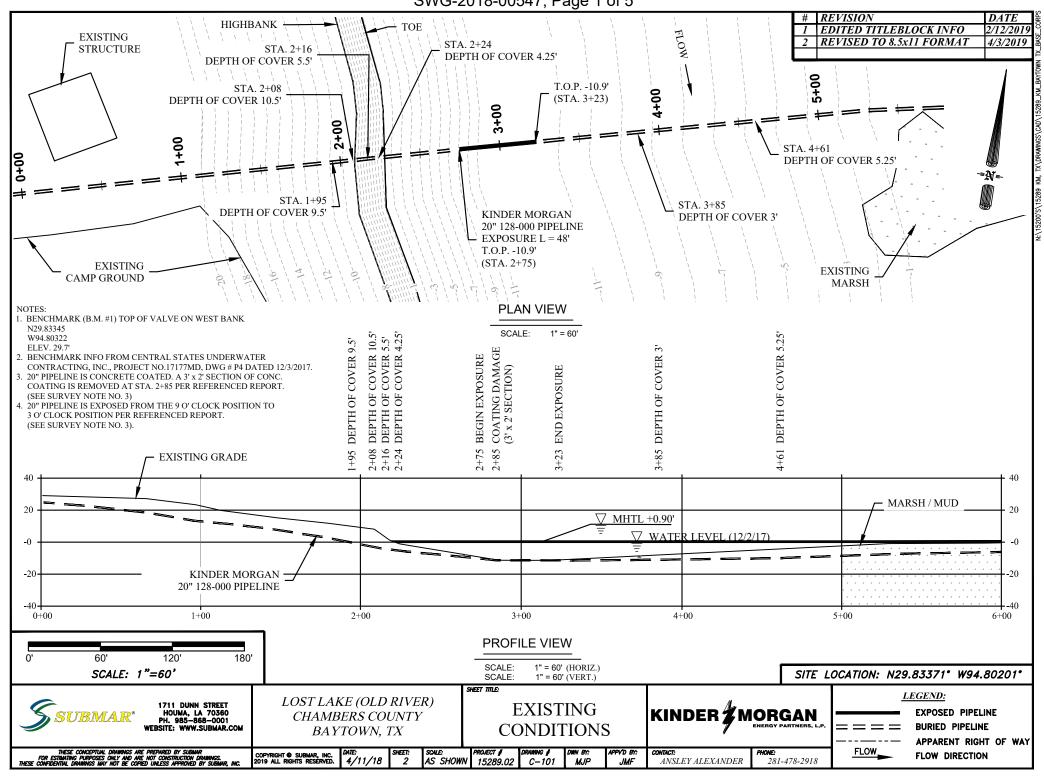

SWG-2018-00547; Page 3 of 5 # REVISION DATE EDITED TITLEBLOCK INFO 2/12/2019 2+65 BEGIN MAT PLACEMENT 2 REVISED TO 8.5x11 FORMAT. 4/3/2019 ADDED MAT NOTE 2+08 DEPTH OF COVER 10.5' 2+24 DEPTH OF COVER 4.25' DEPTH OF COVER 5.5' DEPTH OF COVER 3' COATING DAMAGE (3' x 2' SECTION) BEGIN EXPOSURE 3+23 END EXPOSURE END MAT PLACEMENT 40 20 EDGES OF THE MAT SYSTEM WILL BE JETTED IN RESULTING IN THE PLACEMENT OF APPROX. 34 CYS EXISTING GRADE OF NATIVE FILL SUBMAR MAT SYSTEM 8' x 20' (14 TOTAL) MARSH / MUD V WATER LEVEL (12/2/17) KINDER MORGAN 20" 128-000 PIPELINE 3+00 2+004+00PIPELINE PROFILE VIEW SCALE: 1" = 20' (HORIZ.)

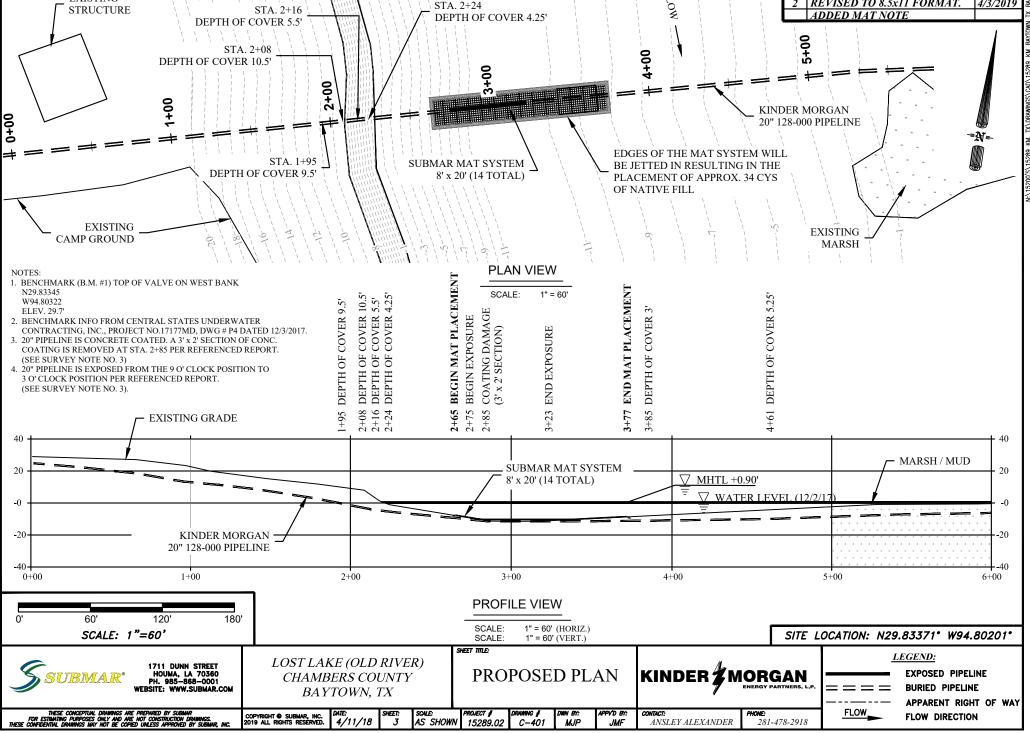

#	REVISION	DATE
1	EDITED TITLEBLOCK INFO	2/12/2019
2	REVISED TO 8.5x11 FORMAT	4/3/2019

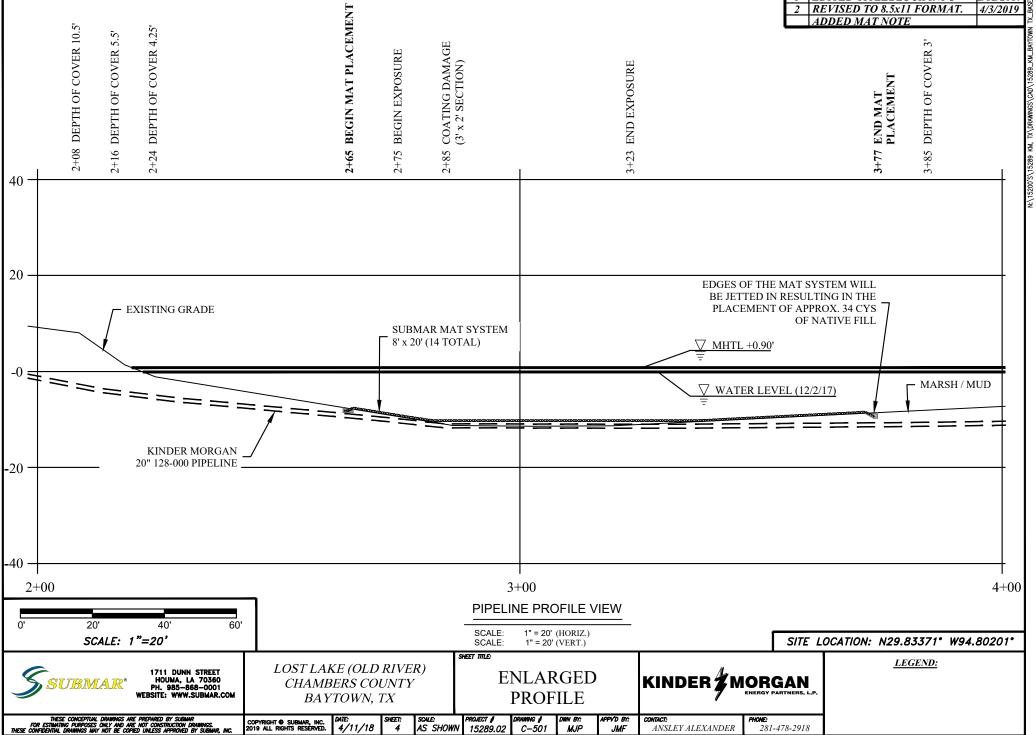

## SUBMAR MAT SYSTEM

SCALE: N.T.S.

1711 DUNN STREET HOUMA, LA 70360 PH. 985-868-0001 WEBSITE: WWW.SUBMAR.COM

LOST LAKE (OLD RIVER) CHAMBERS COUNTY BAYTOWN, TX



LEGEND:

TYPICAL DETAILS

ANSLEY ALEXANDER

PHONE: 281-478-2918

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DATE: 4/11/18

SCALE: PROJECT # AS SHOWN 15289.02

## **CONSTRUCTION NOTES:** # REVISION DATE SHEET INDEX: **ENVIRONMENTAL NOTES:** EDITED TITLEBLOCK INFO 2/12/2019 ALL WORK IS TO BE PERFORMED IN LOW FLOW TITLE 1. THE OWNER SHALL NOTIFY ALL CONTRACTORS, No. REVISED TO 8.5x11 FORMAT 4/3/2019 SUBCONTRACTORS & MATERIAL SUPPLIERS THAT CONDITIONS WHEN POSSIBLE. IT IS PREFERRED C-100 **COVER SHEET** DUMPING OF CHEMICALS INTO THE STORM DRAIN THAT WORK OCCURS DURING THE DRY SEASON **EXISTING CONDITIONS** C-101 (OR OTHERWISE UPSTREAM CONTROLS MANAGED SYSTEM IS PROHIBITED. PROPOSED PLAN C-401 PERMITTEE SHALL MAINTAIN CONSTRUCTION SITE TO MINIMIZE FLOW), CONTRACTOR SHALL C-501 **ENLARGED PROFILE** IN SUCH A CONDITION THAT AN ANTICIPATED MONITOR WEATHER CONDITIONS AND PLAN C-801 TYPICAL DETAILS STORM DOES NOT CARRY WASTES OR CONSTRUCTION ACTIVITIES ACCORDINGLY TO POLLUTANTS OFF THE SITE. POTENTIAL AVOID IN-STREAM WORK DURING RAIN EVENTS SURVEY NOTES: POLLUTANTS INCLUDE BUT ARE NOT LIMITED TO: AND MINIMIZE EXPOSURE OF DISTURBED SOILS SOLID OR LIQUID CHEMICAL SPILLS; WASTES 1. THIS SURVEY IS FOR INFORMATIONAL PURPOSES TO RAINFALL. FROM PAINTS, STAINS, SEALANTS, GLUES, LIMES, ONLY AND WAS CONDUCTED BY CENTRAL STATES CONTRACTING, INC. ON 12/2/2017 CONSTRUCTION EQUIPMENT AND VEHICLES SHALL PESTICIDES, HERBICIDES, WOOD PRESERVATIVES BE IN GOOD WORKING CONDITION AND FREE OF AND SOLVENTS; ASBESTOS FIBERS, PAINT FLAKES HYDRAULIC, FUEL OR OIL LEAKS. THERE SHOULD ALL LOCATIONS OF UNDERGROUND UTILITIES BE A PORT-O-POT ONSITE . FUEL, HEAVY OR STUCCO FRAGMENTS; FUELS, OILS, SHOWN ARE APPROXIMATE. LUBRICANTS AND HYDRAULIC, RADIATOR OR **EQUIPMENT AND ALL CHEMICAL PRODUCTS** LOCATION OF RIGHT OF WAY SHOWN IS SHOULD HAVE ADEQUATE CONTAINMENT. BATTERY FLUIDS; FERTILIZERS, VEHICLE / EQUIPMENT APPROXIMATE, INFORMATION WAS PROVIDED BY PERIMETER EROSION AND SEDIMENT CONTROLS WASH WATER AND CONCRETE WASH WATER: OWNER AND IS FOR INFORMATIONAL PURPOSES CONCRETE, DETERGENT OR FLOATABLE WASTES; SHALL BE ESTABLISHED ALLOWING FOR ONLY. SUBSEQUENT CLEARING AND GRUBBING WITHIN WASTES FROM ANY ENGINE/EQUIPMENT STEAM CLEANING OR CHEMICAL DEGREASING; AND SUPER THE PROJECT AREA. GRADING NOTES: CHLORINATED POTABLE WATER LINE FLUSHING. SALVAGE, FURNISH AND WASTE MATERIALS SHALL BE TEMPORARILY STOCKPILED IN A DESIGNATED DURING CONSTRUCTION, PERMITTEE SHALL ALL WORK SHALL BE IN ACCORDANCE WITH ANY APPROVED AREA UNTIL FINAL HANDLING FOR DISPOSE OF SUCH MATERIALS IN A SPECIFIED SPECIAL REQUIREMENTS OF THE PERMIT. ULTIMATE PLACEMENT. IT IS THE RESPONSIBILITY AND CONTROLLED TEMPORARY AREA ON-SITE. NO EXCAVATION SHALL BE STARTED WITHOUT PHYSICALLY SEPARATED FROM POTENTIAL STORM OF THE SELECTED CONTRACTOR TO ESTABLISH FIRST NOTIFYING ONE CALL 48 HOURS PRIOR TO APPROVED STOCKPILE, STAGING AND ACCESS WATER RUNOFF, WITH ULTIMATE DISPOSAL IN COMMENCEMENT OF WORK. A PRE-GRADING AREAS. IF A RAIN EVENT IS EMINENT, THEN A ACCORDANCE WITH LOCAL, STATE AND FEDERAL MEETING SHALL BE SCHEDULED AT THE SITE SILT FENCE SHALL BE INSTALLED BETWEEN THE REQUIREMENTS. BEFORE START OF GRADING WITH THE FOLLOWING STOCKPILE SOIL AND THE EXISTING STREAM. CONTRACTOR SHALL CONSTRUCT PROJECT AS PEOPLE PRESENT: OWNER, CONTRACTOR & AUTHORIZED IN PERMITTED DRAWINGS. ANY UPON COMPLETION OF WORK, ALL EXCESS OR TEMPORARILY STOCKPILED SOILS, STUMPS OR INSPECTOR. CHANGES MUST FIRST BE APPROVED BY PROJECT PRIOR TO ANY CLEARING, BRUSHING OR OTHER MATERIAL SHALL BE PERMANENTLY MANAGER, OWNER AND INSPECTOR AND DEMOLITION, OTHER THAN WHAT IS AUTHORIZED, REMOVED AND PLACED IN UPLAND STORAGE DOCUMENTED IN THE CONSTRUCTION CREW BOOK. APPROVAL MUST BE OBTAINED FROM THE AREAS, PER LOCAL, STATE AND FEDERAL PROJECT MANAGER AND INSPECTOR. REQUIREMENTS. CUT SLOPES SHALL NOT BE STEEPER THAN 1.5:1 IT MAY BE NECESSARY TO DIVERT STREAM FLOW SLOPE. AROUND THE WORKING AREA TO FACILITATE ALL TRENCH BACKFILLS SHALL BE EXAMINED AND CONSTRUCTION USING A BYPASS PUMP OR CERTIFIED BY THE SITE INSPECTOR PER THE JERSEY BARRIER. IN NO INSTANCE SHALL SILT GRADING PLAN. LADEN WATER BE DISCHARGED INTO THE STREAM. DUST ABATEMENT SHALL BE CONTROLLED BY DIRECTLY OR INDIRECTLY. WATERING. ALL TEMPORARY ACCESS, STAGING, STOCKPILE OR OTHER TEMPORARILY DISTURBED AREAS SANITARY FACILITIES SHALL BE MAINTAINED ON THE SITE PLUS CONTAINMENT. SHALL BE STABILIZED AND REESTABLISHED TO ALL PUBLIC ROADWAYS MUST BE MAINTAINED THEIR PRE-CONSTRUCTION CONDITIONS, DAILY OF ALL DEBRIS DEPOSITED ON THEM AS A INCLUDING GRADE AND VEGETATION. RESULT OF THE CONSTRUCTION OPERATION. ALTHOUGH THIS PLAN MAKES EVERY ATTEMPT TO CLEANING IS TO BE DONE TO THE SATISFACTION ACCOUNT FOR EROSION AND SEDIMENT CONTROL. OF THE OWNER. BANK STABILIZATION AND CONSTRUCTION LOGISTICS, UNFORESEEN CIRCUMSTANCES MAY ARISE THAT REQUIRE ADDITIONAL OR MODIFIED MEASURES TO CONTROL SEDIMENT, STABILIZE RIPARIAN STREAM BANKS AND FACILITATE STRUCTURE INSTALLATION. CONTRACTOR SHALL WORK WITH CLIENT AND ENGINEER, AS NECESSARY, TO ENSURE THAT THE PROJECT IS CONSTRUCTED IN ACCORDANCE WITH THE INTENT OF THESE PLANS. CONTROL POINTS: No. | NORTHING (N) EASTING (E) **ELEVATION (Z)** SITE LOCATION: N29.83371° W94.80201° SHEET TITLE: LEGEND: LOST LAKE (OLD RIVER) 1711 DUNN STREET KINDER ZMORGAN HOUMA, LA 70360 PH. 985-868-0001 **COVER SHEET** CHAMBERS COUNTY WEBSITE: WWW.SUBMAR.COM BAYTOWN, TX THESE CONCEPTUAL DRAWINGS ARE PREPARED BY SUBMAR FOR ESTIMATING PURPOSES ONLY AND ARE NOT CONSTRUCTION DRAWINGS. THESE CONFIDENTIAL DRAWINGS MAY NOT BE COPED UNLESS APPROVED BY SUBMAR, INC. SCALE: CONTACT: PHONE: COPYRIGHT @ SUBMAR, INC. 2019 ALL RIGHTS RESERVED. 4/11/18 AS SHOWN 15289.02 ANSLEY ALEXANDER 281-478-2918 C-100